
## GRORGIA HIGHWAY 138 AT GEORGIA HIGHWAY 314

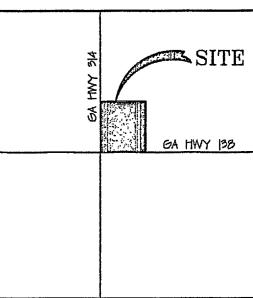

BRUNDAGE

SITE DEVELOPMENT DRAWINGS

(DOT ENTRANCE DRAWINGS)

LOCATED IN OF THE 13th DISTRICT CLAYTON COUNTY

GEORGIA

JOB NO.
00027
SCALE
NOT TO SCA

COVER



NO.	REVISIONS	DATE
		<del></del>
<b>  </b>		

YOU DIG GEORGIA... CALL US FIRST! 1-800-282-7411 UTILITIES PROTECTION CENTER IT'S THE LAW

NOTES:

2. ZONING: NB AND GB

I. OWNER/DEVELOPER: THE PROPERTIES, LLLP

100 PETROL POINT

CONTACT: MIKE HYDE

T10-487-9997

MINIMUM LOT AREA - 10,000 SF

HEIGHT LIMIT - 35' (NB), 75' (GB)

TO F.I.R.M. NO. 130041 0015 C. DATED NOV. 6, 1991.

| FUELING ATTENDANT X | SPACE/ATTENDANT = | SPACE

3500 SQ. FT. X | SPACE/300 SQ. FT. = 12 SPACES

3500 SQ. FT. X | SPACE/300 SQ. FT. = 12 SPACES

TOTAL SPACES REQUIRED = 25 SPACES TOTAL PARKING PROPOSED = 36 SPACES

HANDICAP SPACES REQUIRED = 2 SPACES HANDICAP SPACES PROPOSED = 2 SPACES

MINIMUM LOT WIDTH - 100

FRONT SETBACK - 50 REAR SETBACK - 0

SIDE SETBACK - 0

5. ACREAGE OF SITE - 1.42 AC.

6. TAX ID NUMBER - 13/860 BOOT

FALLOWING CALCULATIONS)

7. REQUIRED PARKING-

PEACHTREE CITY, GA. 30269

3. BOUNDARY AND TOPOGRAPHIC SURVEY BY W.S. BODKIN SURVEYING, LLC.

4. THIS PROPERTY DOES NOT INCLUDE A FLOOD HAZARD AREA ACCORDING

GASOLINE SERVICE STATION - 2 SPACES PER GAS PUMP PLUS 3 SPACES FOR

RETAIL STORE UPPER LEVEL - | SPACE PER 300 SQ. FT. OF GROSS FLOOR AREA

RETAIL STORE LOWER LEVEL - | SPACE PER 300 SQ. FT. OF GROSS FLOOR AREA

EACH SERVICE BAY OR SIMILAR FACILITY PLUS | SPACE FOR EACH ATTENDANT 6 PUMP ISLANDS X 2 SPACES/PUMP = 12 SPACES (THESE SPACES ARE

LOCATED ADJACENT TO EACH PUMP ISLAND AND ARE NOT INCLUDED IN THE

<u>LEGEND</u>

CONSTRUCTION EXIT

RETROFIT

DISTURBED AREA STABILIZATION

(WITH TEMPORARY SEEDING)

FILTER RING

ROCK DAM

RETAINING WALL

SEDIMENT BARRIER

TEMPORARY SEDIMENT BASIN

STORM DRAIN OUTLET PROTECTION

DISTURBED AREA STABILIZATION (WITH PERMANENT VEGETATION) <u>GENERAL LEGEND</u>

- - - - E/P EXISTING EDGE OF PAVEMENT

EXISTING CONTOUR \_ \_ \_ \_ 930- \_ \_ \_ \_

NEW CONTOUR

EXISTING WATER LINE

EXISTING OVERHEAD ELECTRIC LINE DIRECTION OF TRAFFIC

PAINTED TRAFFIC ARROW

EXISTING SIGN NEW SIGN

EXISTING FIRE HYDTANT RELOCATED FIRE HYDRANT

EXISTING POWER/UTILITY POLE

CONCRETE STRAIN POLE WOOD STRAIN POLE

**GUY WIRE** 

SCHEDULE OF DRAWINGS

DOT ENTRANCE LAYOUT PLAN

EROSION AND SEDIMENTATION CONTROL DETAILS

COVER

EROSION AND SEDIMENTATION CONTROL PLAN

GRADING PLAN


NO. DRAWING


NO.	REVISIONS	DATE


SHEET NO.


SHEET 1 OF 5

☐ RELEASED FOR CONSTRUCTION FOR REVIEW ONLY

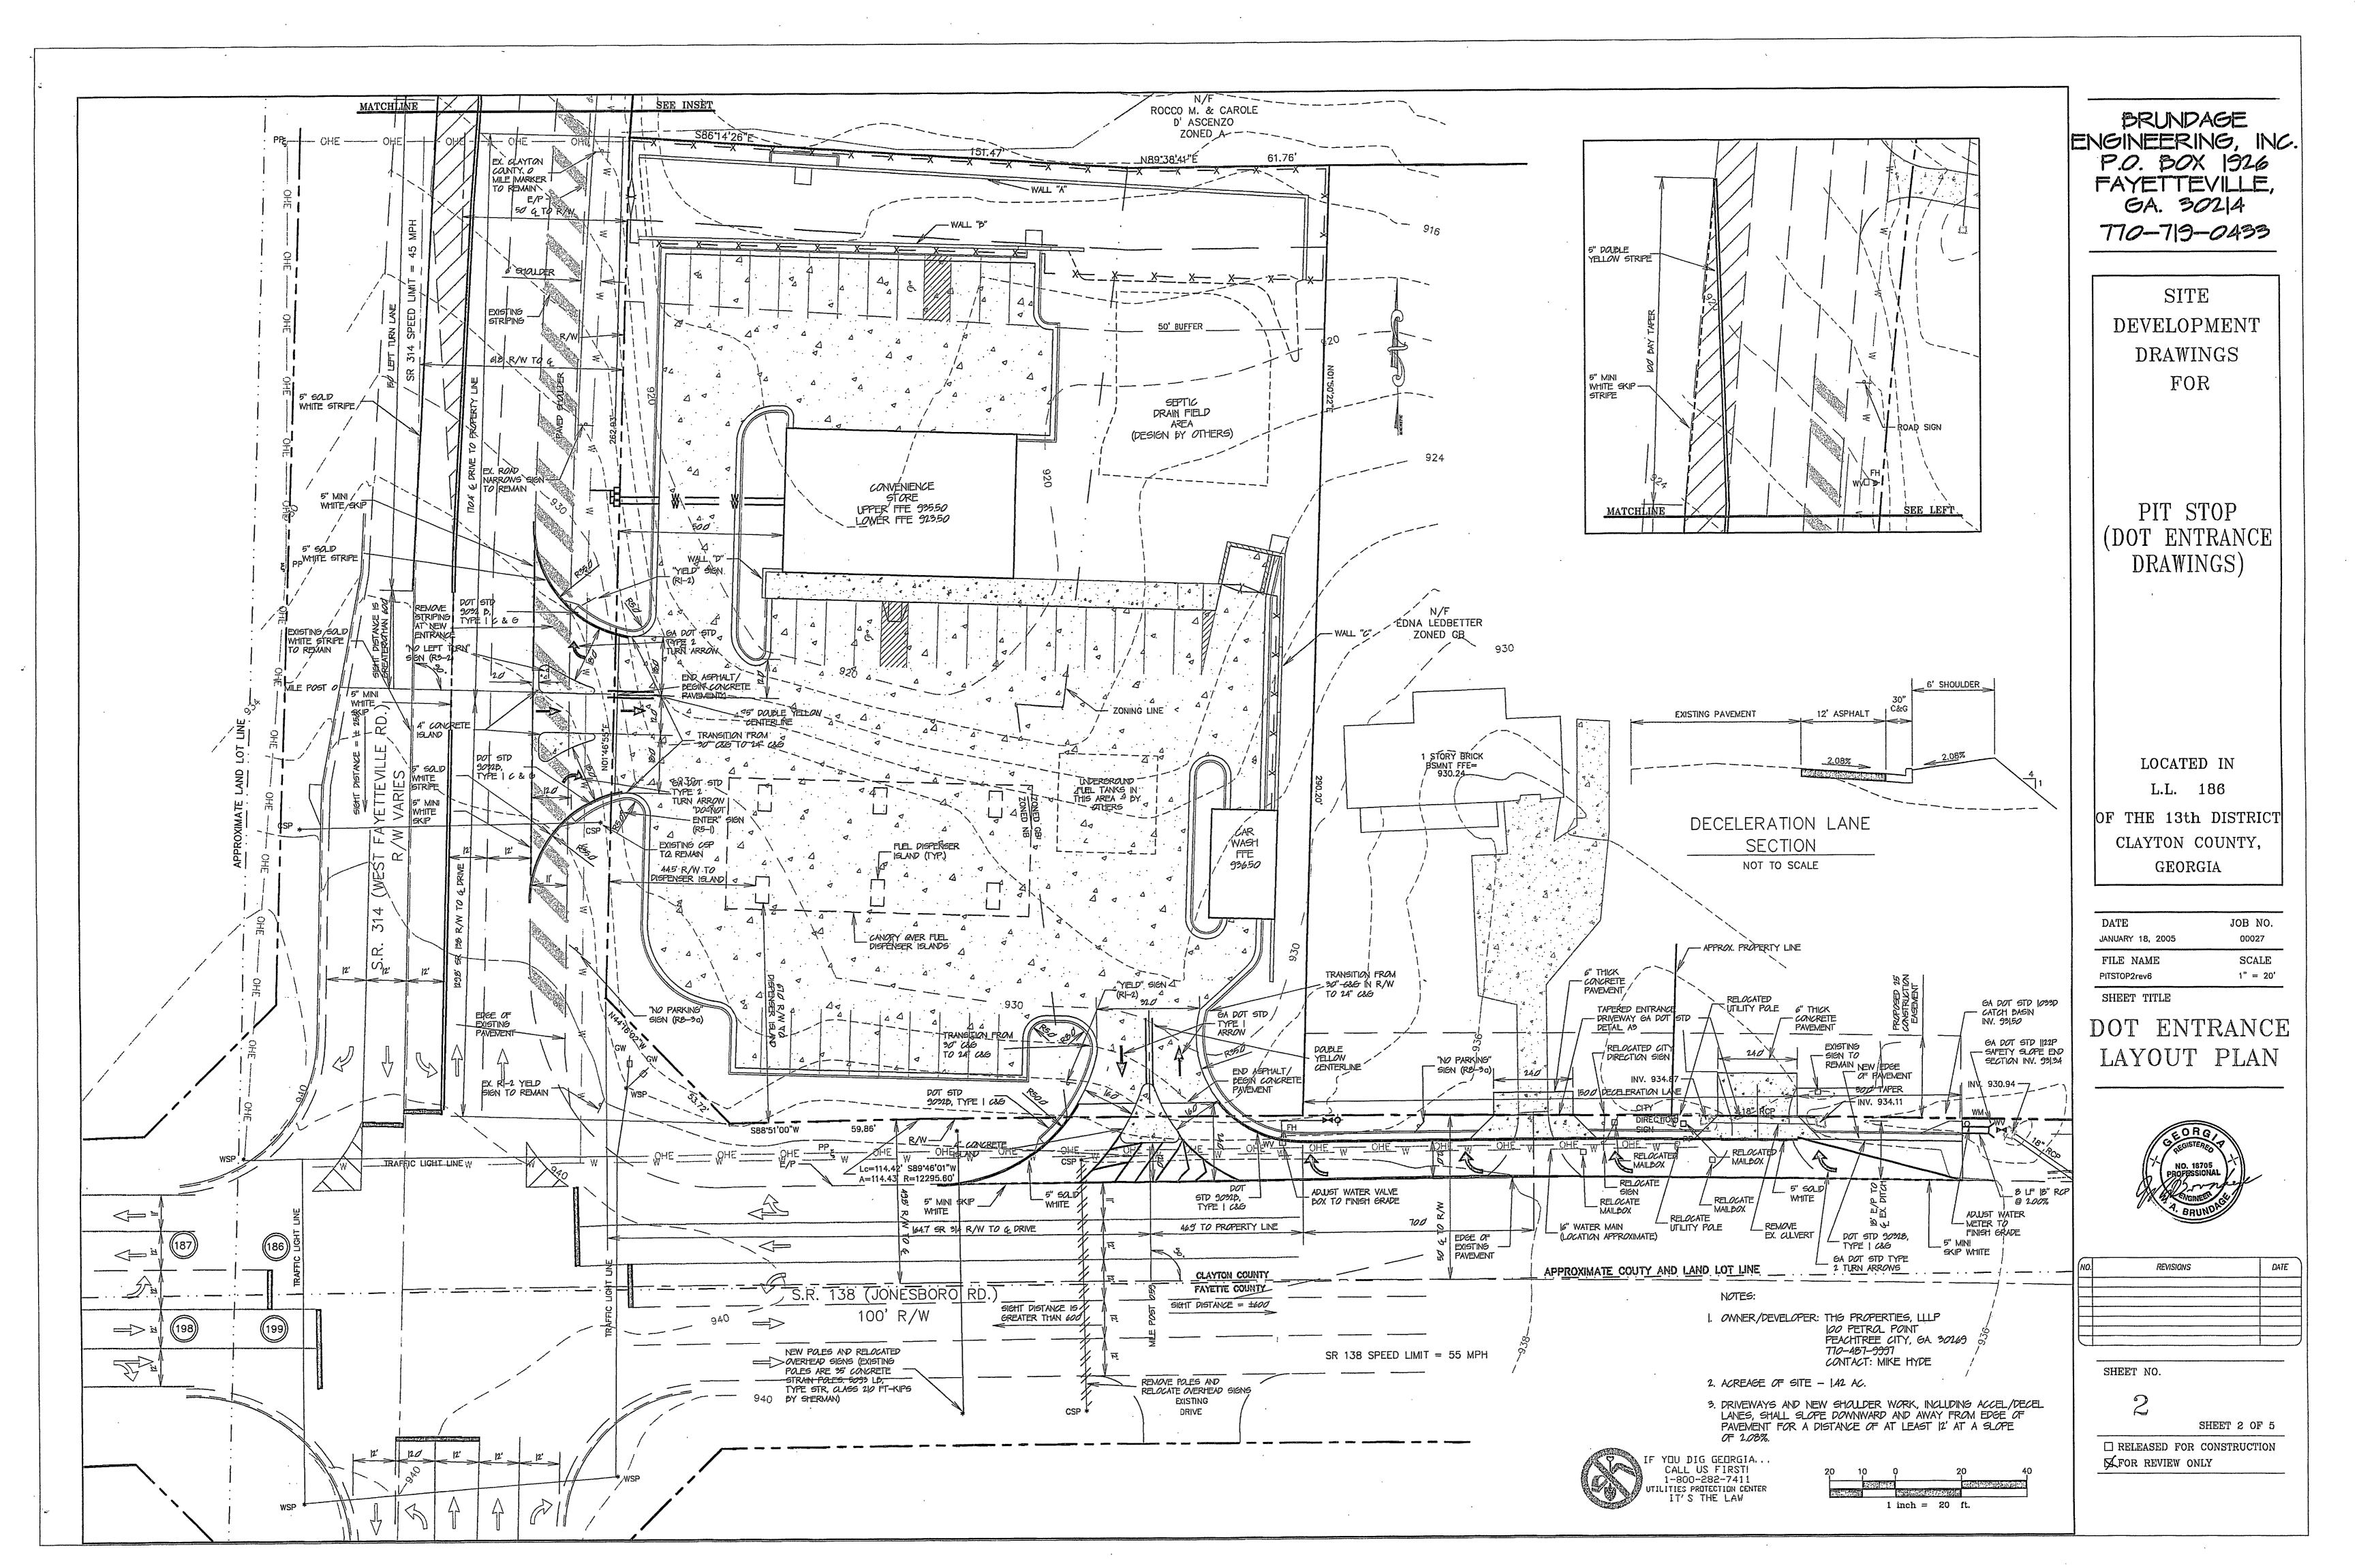

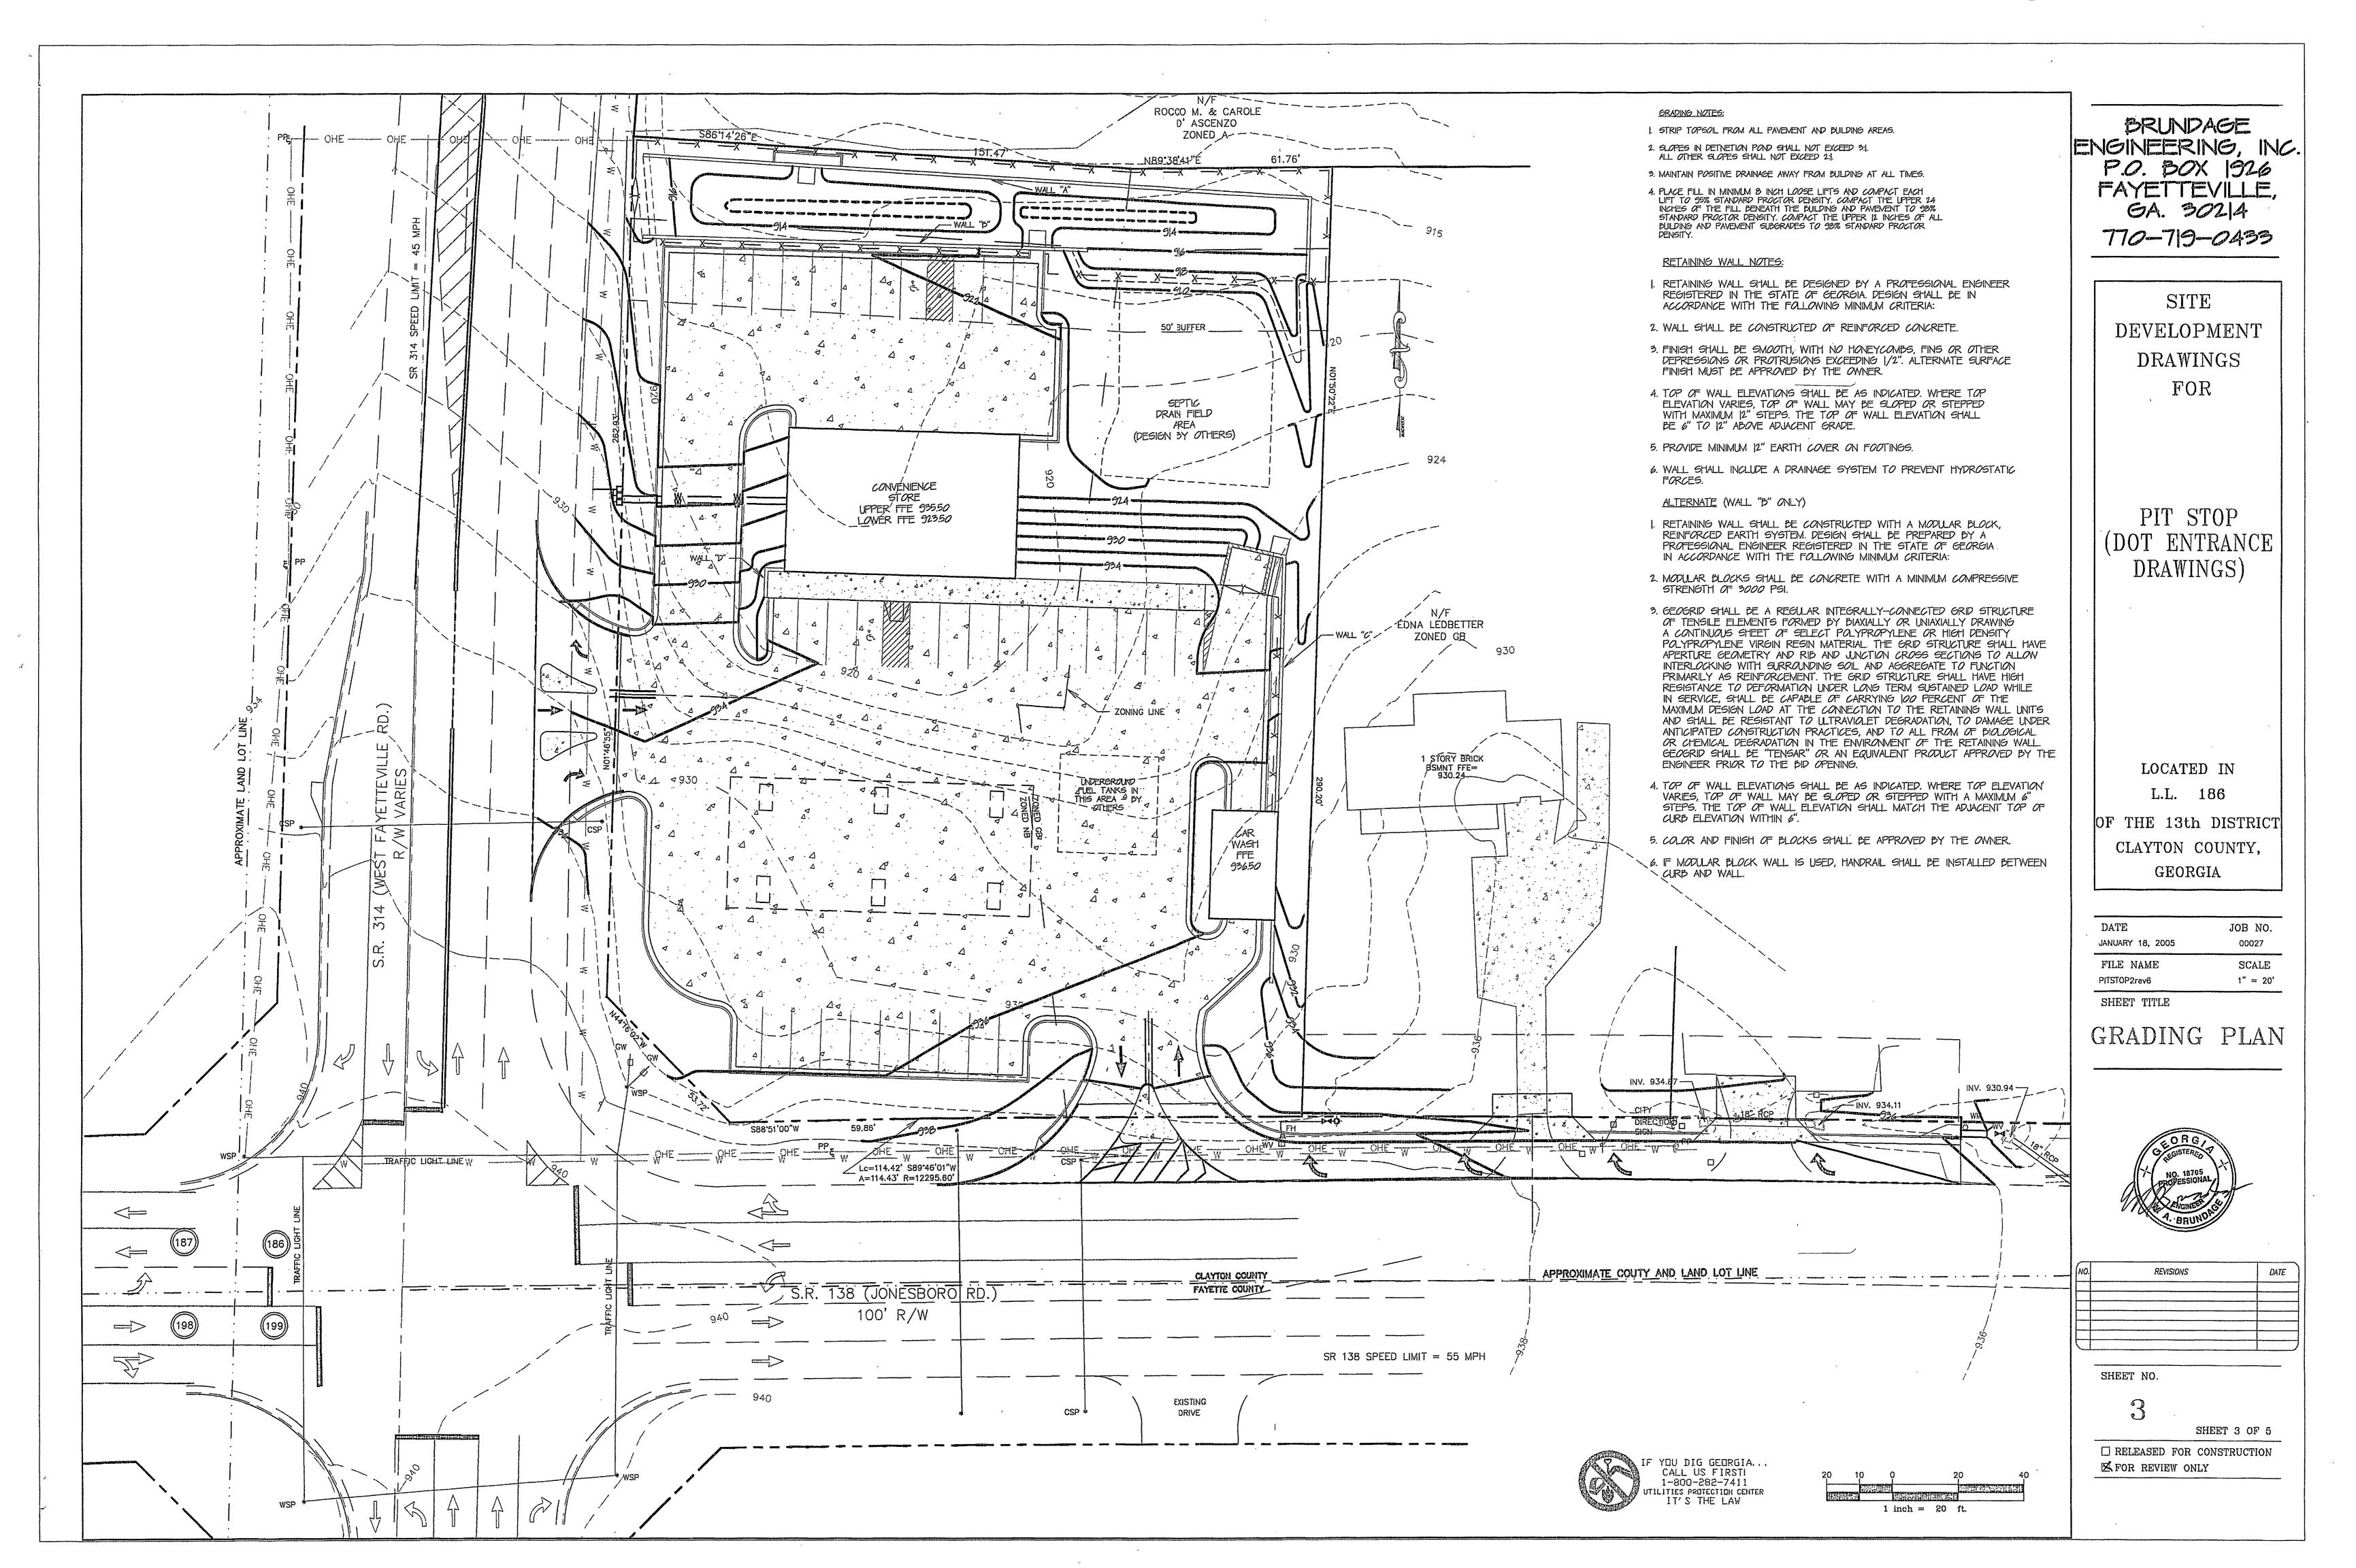

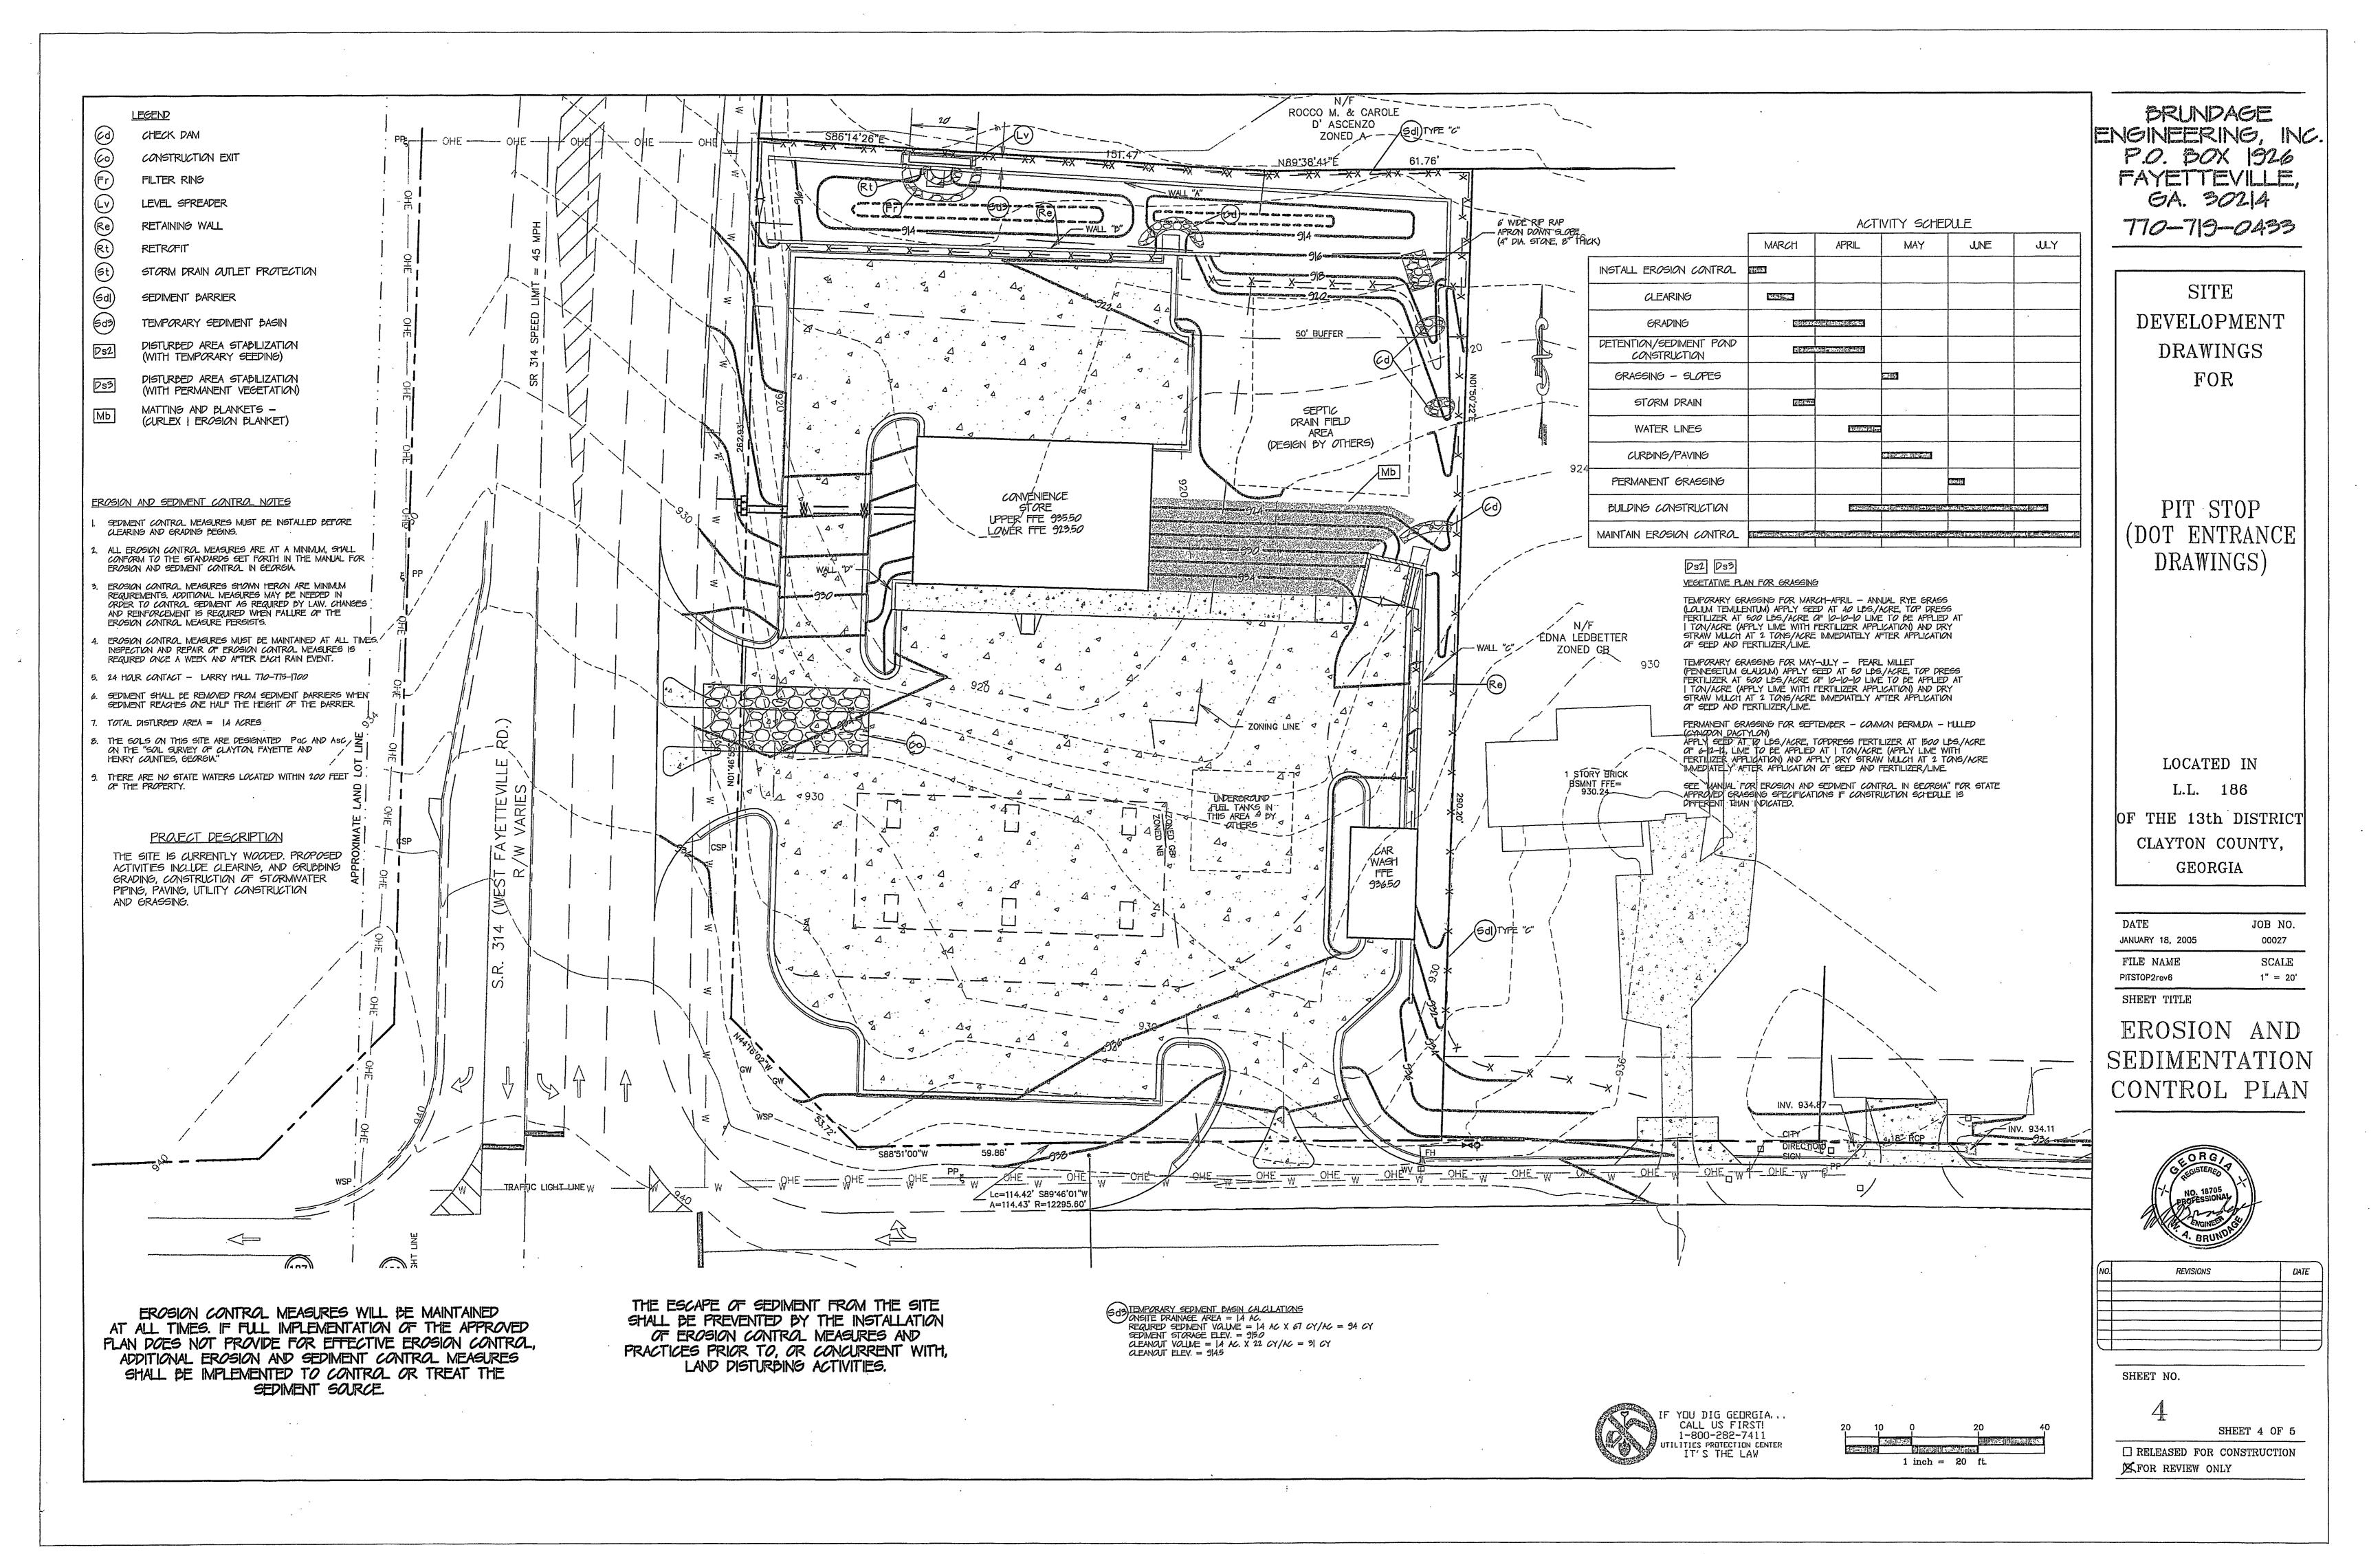

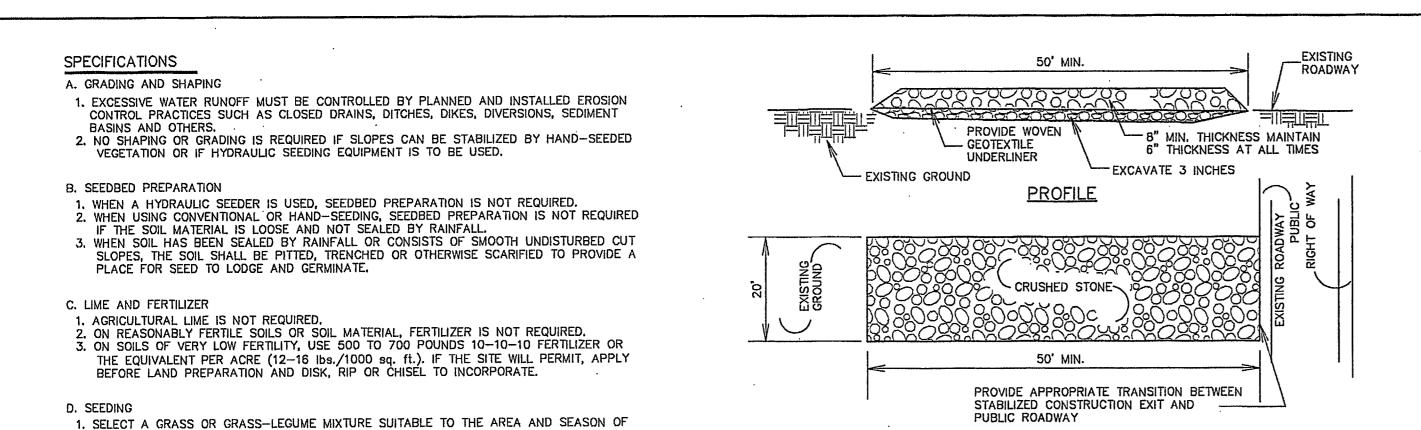

## CONSTRUCTION SPECIFICATIONS:

1. STONE SIZE - USE 1.5" TO 3.5" CRUSHED STONE. 2. LENGTH - AS EFFECTIVE, BUT NOT LESS THAN 50'.

MUST BE REMOVED IMMEDIATELY.

THICKNESS - NOT LESS THAN EIGHT (8) INCHES. WIDTH - NOT LESS THAN FULL WIDTH OF ALL POINTS OF INGRESS OR EGRESS. 5. WASHING - WHEN NECESSARY, WHEELS SHALL BE CLEANED TO REMOVE SEDIMENT PRIOR TO ENTRANCE ONTO PUBLIC RIGHTS-OF-WAY. WHEN WASHING IS REQUIRED IT SHALL BE DONE ON AN AREA STABILIZED WITH CRUSHED STONE WHICH DRAINS INTO AN APPROVED SEDIMENT TRAP OR SEDIMENT BASIN. ALL SEDIMENT SHALL BE PREVENTED FROM ENTERING ANY STORM DRAIN, DITCH, OR WATERCOURSE THROUGH THE USE OF SAND BAGS, GRAVEL, BOARDS, OR OTHER APPROVED METHODS. 6. MAINTENANCE - THE ENTRANCE SHALL BE MAINTAINED IN A CONDITION WHICH WILL PREVENT TRACKING OR FLOWING OF SEDIMENT ONTO PUBLIC RIGHTS-OF-WAY. THIS MAY REQUIRE PERIODIC TOP DRESSING WITH ADDITIONAL STONE AS CONDITIONS

DEMAND, AND REPAIR AND/OR CLEANOUT OF ANY MEASURES USED TO TRAP SEDIMENT.

ALL SEDIMENT SPILLED, DROPPED, WASHED, OR TRACKED ONTO PUBLIC RIGHTS-OF-WAY

(WITH TEMPORARY SEEDLINGS) NOT TO SCALE

SEED. SUBSEQUENT APPLICATIONS SHOULD BE MADE WHEN NEEDED.

2. APPLY SEED UNIFORMLY BY HAND, CYCLONE SEEDER, DRILL, CULTIPACKER-SEEDER, OR HYDRAULIC SEEDER (SLURRY INCLUDING SEED AND FERTILIZER). DRILL OR CULTIPACKER-

TEMPORARY VEGETATION CAN, IN MOST CASES, BE ESTABLISHED WITHOUT THE USE OF MULCH.

MULCH WITHOUT SEEDING SHOULD BE CONSIDERED FOR SHORT TERM PROTECTION. SEE Ds1 -

SEEDERS SHOULD NORMALLY PLACE SEED ONE-HALF TO ONE INCH DEEP.

IF WATER IS APPLIED, IT MUST BE AT A RATE NOT CAUSING RUNOFF AND EROSION.

THOROUGHLY WET THE SOIL TO A DEPTH THAT WILL INSURE GERMINATION OF THE

DISTURBED AREA STABILIZATION (WITH MULCHING ONLY).

THE YEAR.

E. MULCHING

SPECIFICATIONS STONE PAD CONSTRUCTION EXIT NOT TO SCALE A. GRADING AND SHAPING

VERTICAL BANKS SHALL BE SLOPED TO ENABLE PLANT ESTABLISHMENTS. 2. WHEN CONVENTIONAL SEEDING AND FERTILIZING IS TO BE DONE, GRADE AND SHAPE WHERE FEASIBLE AND PRACTICAL, SO THAT EQUIPMENT CAN BE USED SAFELY AND EFFICIENTLY DURING SEEDBED PREPARATION, SEEDING, MULCHING AND MAINTENANCE

1. GRADING AND SHAPING IS NOT NORMALLY REQUIRED WHERE HYDRAULIC SEEDING AND FERTILIZING EQUIPMENT IS TO BE USED.

3. CONCENTRATIONS OF WATER THAT WILL CAUSE EXCESSIVE SOIL EROSION WILL BE DIVERTED TO A SAFE OUTLET. DIVERSIONS AND OTHER TREATMENT PRACTICES MUST CONFORM WITH THE APPROPRIATE STANDARDS AND SPECIFICATIONS.

1. SEEDBED PREPARATION IS NOT REQUIRED WHERE HYDRAULIC SEEDING AND FERTILIZING EQUIPMENT IS TO BE USED. 2. WHEN CONVENTIONAL SEEDING IS TO BE USED, SEEDBED PREPARATION WILL BE DONE AS FOLLOWS:

1. TILLAGE AT A MINIMUM, SHALL ADEQUATELY LOOSEN THE SOIL TO A DEPTH OF 4 TO 6 INCHES; ALLEVIATE COMPACTION; INCORPORATE LIME AND FERTILIZER; SMOOTH AND FIRM THE SOIL; ALLOW FOR THE PROPER PLACEMENT OF SEED SPRIGS, OR PLANTS; AND ALLOW FOR THE ANCHORING OF STRAW OR HAY MULCH IF A DISK IS TO BE USED. TILLAGE MAY BE DONE WITH ANY SUITABLE EQUIPMENT.

3. TILLAGE MAY BE DONE ON THE CONTOUR WHERE FEASIBLE.
4. ON SLOPES TOO STEEP FOR THE SAFE OPERATION OF TILLAGE EQUIPMENT, THE SOIL SURFACE WILL BE PITTED OR TRENCHED ACROSS THE SLOPE WITH APPROPRIATE HAND TOOLS TO PROVIDE A PLACE 6 TO 8 INCHES APART IN WHICH

SEED MAY LODGE AND GERMINATE. B. INDIVIDUAL PLANTS. 1. WHERE INDIVIDUAL PLANTS ARE TO BE SET, THE SOIL WILL BE PREPARED BY EXCAVATING HOLES, OPENING FURROWS, OR DIBBLE PLANTING. 2. FOR NURSERY STOCK PLANTS, HOLES SHALL BE LARGE ENOUGH TO ACCOMMODATE ROOTS WITHOUT CROWDING.
3. WHERE PINE SEEDLINGS ARE TO BE PLANTED, SUBSOIL UNDER THE ROW 36 INCHES DEEP ON THE CONTOUR 4 TO 6 MONTHS PRIOR TO PLANTING. SUBSOILING SHOULD BE DONE WHEN THE SOIL IS DRY, PREFERABLY IN AUGUST OR

C. LIME AND FERTILIZER -- RATES AND ANALYSIS WHERE PERMANENT VEGETATION IS TO BE ESTABLISHED, AGRICULTURAL LIME SHALL BE APPLIED AS INDICATED BY


SOIL TEST OR AT THE RATE OF 1 TO 2 TONS PER ACRE. AGRICULTURAL LIME SHALL BE WITHIN THE SPECIFICATIONS OF THE GEORGIA DEPARTMENT OF AGRICULTURE. LIME SPREAD BY CONVENTIONAL EQUIPMENT WILL BE "GROUND LIMESTONE." GROUND LIMESTONE IS CALCITIC OR DOLOMITIC LIMESTONE GROUND SO THAT 90 PERCENT OF THE MATERIAL WILL PASS THROUGH A 10-MESH SIEVE AND NOT LESS THAN 25 PERCENT WILL PASS THROUGH A 100-MESH SIEVE. AGRICULTURAL LIME SPREAD BY HYDRAULIC SEEDING EQUIPMENT WILL BE "FINELY GROUND LIMESTONE." FINELY GROUND LIMESTONE IS CALCITIC OR DOLOMITIC LIMESTONE GROUND SO THAT 98 PERCENT OF THE MATERIAL WILL PASS THROUGH A 20 MESH SIEVE AND NOT LESS THAN 70 PERCENT WILL PASS THROUGH A 100 MESH SIEVE.

D. LIME FERTILIZER -- APPLICATION 1. WHEN HYDRAULIC SEEDING EQUIPMENT IS USED:


A, THE INITIAL FERTILIZER WILL BE MIXED WITH SEED, INOCULANT (IF NEEDED) AND WOOD CELLULOSE OR WOOD PULP FIBER MULCH AND APPLIED IN A SLURRY. THE SLURRY WILL BE AGITATED DURING APPLICATION TO KEEP THE INGREDIENTS THOROUGHLY MIXED. THE MIXTURE WILL BE SPREAD UNIFORMLY OVER THE AREA WITHIN ONE HOUR AFTER BEING PLACED IN THE HYDROSEEDER. B, FINELY GROUND LIMESTONE WILL BE MIXED WITH WATER AND APPLIED IMMEDIATELY AFTER MULCHING IS COMPLETED OR IN COMBINATION WITH THE TOP DRESSING. 2. WHEN CONVENTIONAL PLANTING IS TO BE DONE, LIME AND FERTILIZER WILL BE APPLIED UNIFORMLY IN ONE OF

A. APPLY BEFORE LAND PREPARATION SO THAT IT WILL BE MIXED WITH THE SOIL DURING SEEDBED PREPARATION; OR, B MIX WITH THE SOIL USED TO FILL THE HOLES, DISTRIBUTE IN FURROWS; OR C. BROADCAST AFTER STEEP SURFACES AND SCARIFIED, PITTED OR TRENCHED. D. A FERTILIZER PELLET WILL BE PLACED AT ROOT DEPTH..


DS3 DISTURBED AREA STABILIZATION (WITH PERMANENT SEEDLINGS) NOT TO SCALE

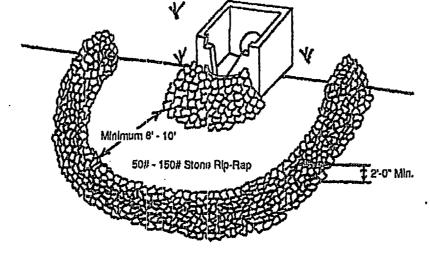



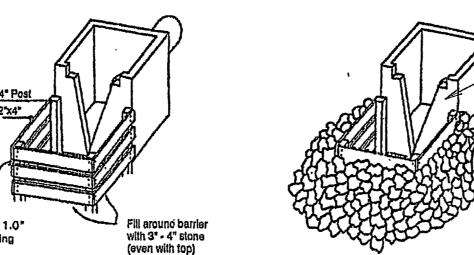


SLOTTED BOARD DAM WITH STONE FILTER

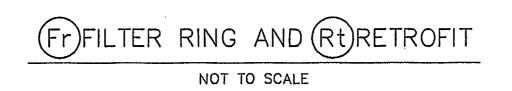

THE FOLLOWING TYPES OF CHECK DAMS ARE USED FOR THIS STANDARD:

1. STONE CHECK DAMS SHOULD BE CONSTRUCTED OF GRADING SIZE 2-10 INCH STONE, (SEE FIGURE), MECHANICAL OR HAND PLACEMENT SHALL BE REQUIRED TO INSURE COMPLETE COVERAGE OF ENTIRE WIDTH OF DITCH OR SWALE AND THAT CENTER OF DAM IS LOWER THAN EDGES. 2. HAYBALE CHECK DAMS: STAKED AND EMBEDDED HAYBALES MAY BE USED AS TEMPORARY CHECKDAMS IN CONCENTRATED FLOW AREAS WHILE VEGETATION IS BECOMING ESTABLISHED, THEY SHOULD NOT BE USED WHERE THE DRAINAGE AREA EXCEEDS 2 ACRES. HAYEBALES SHOULD BE EMBEDDED A MINIMUM OF 4 INCHES. (SEE FIGURE).

PERIODIC INSPECTION AND REQUIRED MAINTENANCE MUST BE PROVIDED. SEDIMENT SHOULD BE REMOVED WHEN IT REACHES A DEPTH OF ONE-HALF THE ORIGINAL DAM HEIGHT OR BEFORE. CHECK DAMS MUST BE REMOVED AT THE COMPLETION OF THEIR USEFUL LIFE. AFTER REMOVAL , THE AREA RENEATH THE DAM SHOULD BE SEEDED AND MULCHED IMMEDIATELY.

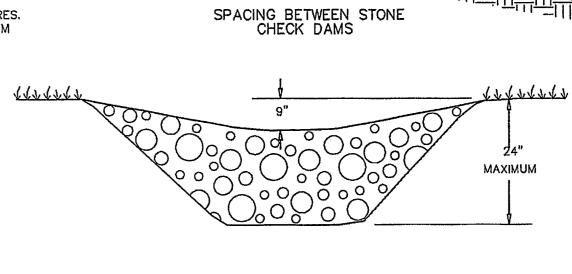

L = THE DISTANCE SUCH THAT POINTS

A and B ARE OF EQUAL ELEVATION

MAXIMUM

NOT TO SCALE

EXTENSION OF FABRIC AND

WIRE INTO TRENCH

NOTE: GEO-TEXTILE FABRIC SHALL BE ERECTED WITH A WIRE BACKING TYPE "C" ONLY.

EMBEDDING DETAIL

FLOW ---

FILTER FABRIC -

BRUNDAGE ENGINEERING, INC. P.O. BOX 1926 FAYETTEVILLE

> DEVELOPMENT DRAWINGS FOR

PIT STOP DRAWINGS)

LOCATED IN

OF THE 13th DISTRICT CLAYTON COUNTY, GEORGIA

**JANUARY 18, 2005** 00027 SCALE FILE NAME 1" = 20'PITSTOP2rev6 SHEET TITLE

JOB NO.





REVISIONS

SHEET NO.

SHEET 5 OF 5

☐ RELEASED FOR CONSTRUCTION FOR REVIEW ONLY

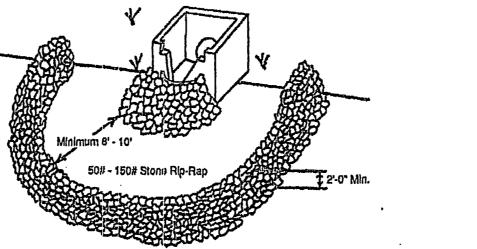

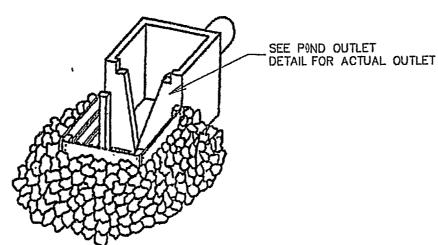

1. SET POSTS AND EXCAVATE A 4"X4" TRENCH

UP SLOPE ALONG THE LINE OF POSTS.

3. ATTACH THE (36" TYPE A & C, 22" TYPE B) BACKFILL AND COMPACT THE EXCAVATED SOIL. FILTER FABRIC TO THE POST AND EXTEND IT INTO THE TRENCH. SEE EMBEDDING DETAIL

\_ "A" & "B" (TYP) 1.3 LB/FT (MIN.)

(TYP.)

4' - STEEL POST TYPE "C"

TO THE POSTS.

3' - WOOD POST TYPE (TYPE "C" SILT FENCE ONLY)

2. ATTACH WOVEN WIRE REINFORCEMENT FENCING

CONSTRUCTION OF SILT FENCE NOT TO SCALE